

GROUND FLOOR PLAN

SCALE 1:100

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DEVELOPMENT SUMMARY CHILD CARE CENTRE

AREAS

SUBJECT SITE	1387M2 (100%)
SITE COVERAGE	699.0M2 (50.4%)
TOTAL IMPERVIOUS AREA	957.5M2 (69%)
TOTAL PERMEABLE AREA	429.5M2 (31%)
GROUND FLOOR AREA	346.8M2
FIRST FLOOR AREA	288.3M2
BALCONY PLAY AREA	318.0M2
TOTAL FLOOR AREA	954.6M2
TOTAL CHILD CARE PLACES	96
OUTDOOR AREA REQUIRED	672M2
OUTDOOR AREA PROVIDED	706M2
CARPARK SPACES REQUIRED	21
CARPARK SPACES PROVIDED	21

ALL LEVELS TO AHD

CFA REQUIREMENTS

Access to the static water supply for fire fighting purposes must be provided which meets the following requirements:

- Access must have a load limit of at least 15 tonnes.
- Curves must have a minimum inner radius of 10m.
- The average grade must be no more than 1 in 7 (14.4 per cent) (8.1 degrees) with a maximum of no more than 1 in 5 (20 per cent) (11.3 degrees) for no more than 50m.
- Have a minimum trafficable width of 3.5m of all- weather construction.
- Be clear of encroachments for at least 0.5m on each side and 4m above the accessway.
- Dips must have no more than a 1 in 8 (12.5 per cent) (7.1 degrees) entry and exit angle.

ENERGY NOTES

- 10,000 litre rainwater tank plumbed to all toilets & garden taps

- Balcony to drain into 3.5m2 raingarden
- 4 star WELS SHOWER (6.0-7.5L/min) - 6 star WELS kitchen & bathroom taps
- 4 star WELS toilets

- 4 star WELS dishwashers

- All plants to be native low water use varieties (except for plants in

raingarden, which must be suitable species for application)

- All exposed floors and ceilings (forming part of the envelope) to have minimum 10% improvement in required NCC2019 insulation levels (total R-value upwards and downwards)

- Wall and glazing to meet the required NCC2019 facade calculator (or better than the total allowance)

- Heating and cooling systems to be within one Star of the most efficient equivalent capacity unit available, or Coefficient of Performance (CoP) & Energy Efficiency Ratios (EER) not less than 85% of the CoP & EER of the most efficient equivalent capacity unit available

- Water heating systems within one star of the best available, or 85% or better than the most efficient equivalent capacity unit

Maximum illumination power density requirements in Table J6.2a of the NCC 2019 Vol 1 are to be met
All regular use areas are naturally ventilated

- 2 bike racks provided

- All paints, sealants, adhesives, carpet and engineered wood must meet maximum total indoor pollutant emission limits

project no. X

date AUG22

scale 1:100 @ AO

		11 1 1
project	propo	osed development
	@	1A GEAR AVE MT EVELYN

title GROUND FLOOR



FIRST FLOOR PLAN

SCALE 1:100

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Dwg No: TP04


project no. 🛛 🗙

date AUG22


scale 1:100 @ A0

project	proposed development				
	0	1A GEAR AVE MT EVELYN			

title FIRST FLOOR

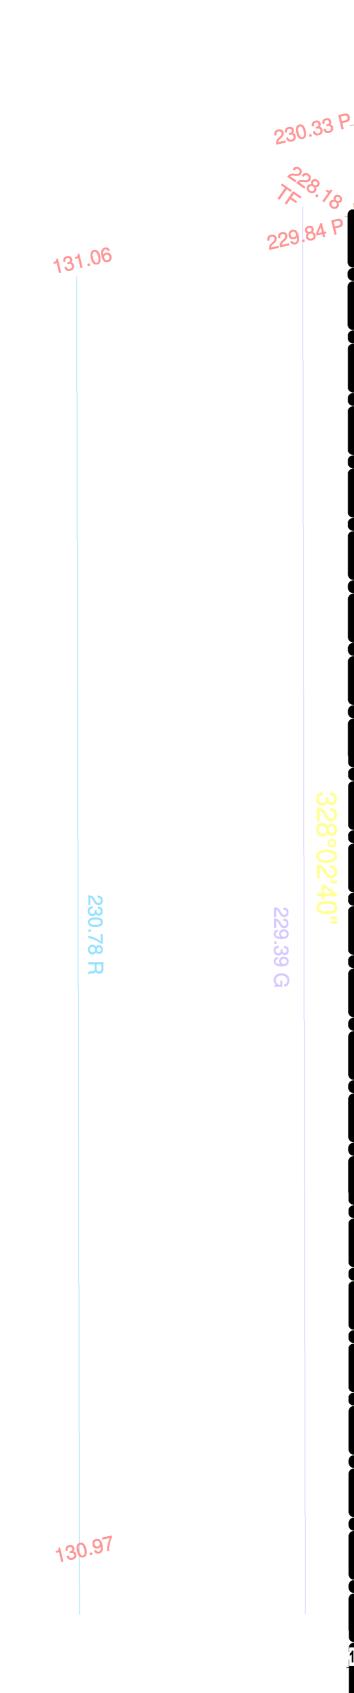

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issue date	note	project proposed development @ 1A GEAR AVE MT EVELYN	Dwg No: TDAS
A AUG22	TOWN PLANNING SUBMISSION		v
B NOV22	RFI	project no.	Х
		date	AUG22
		title ROOF PLAN scale	1:100 @ A0

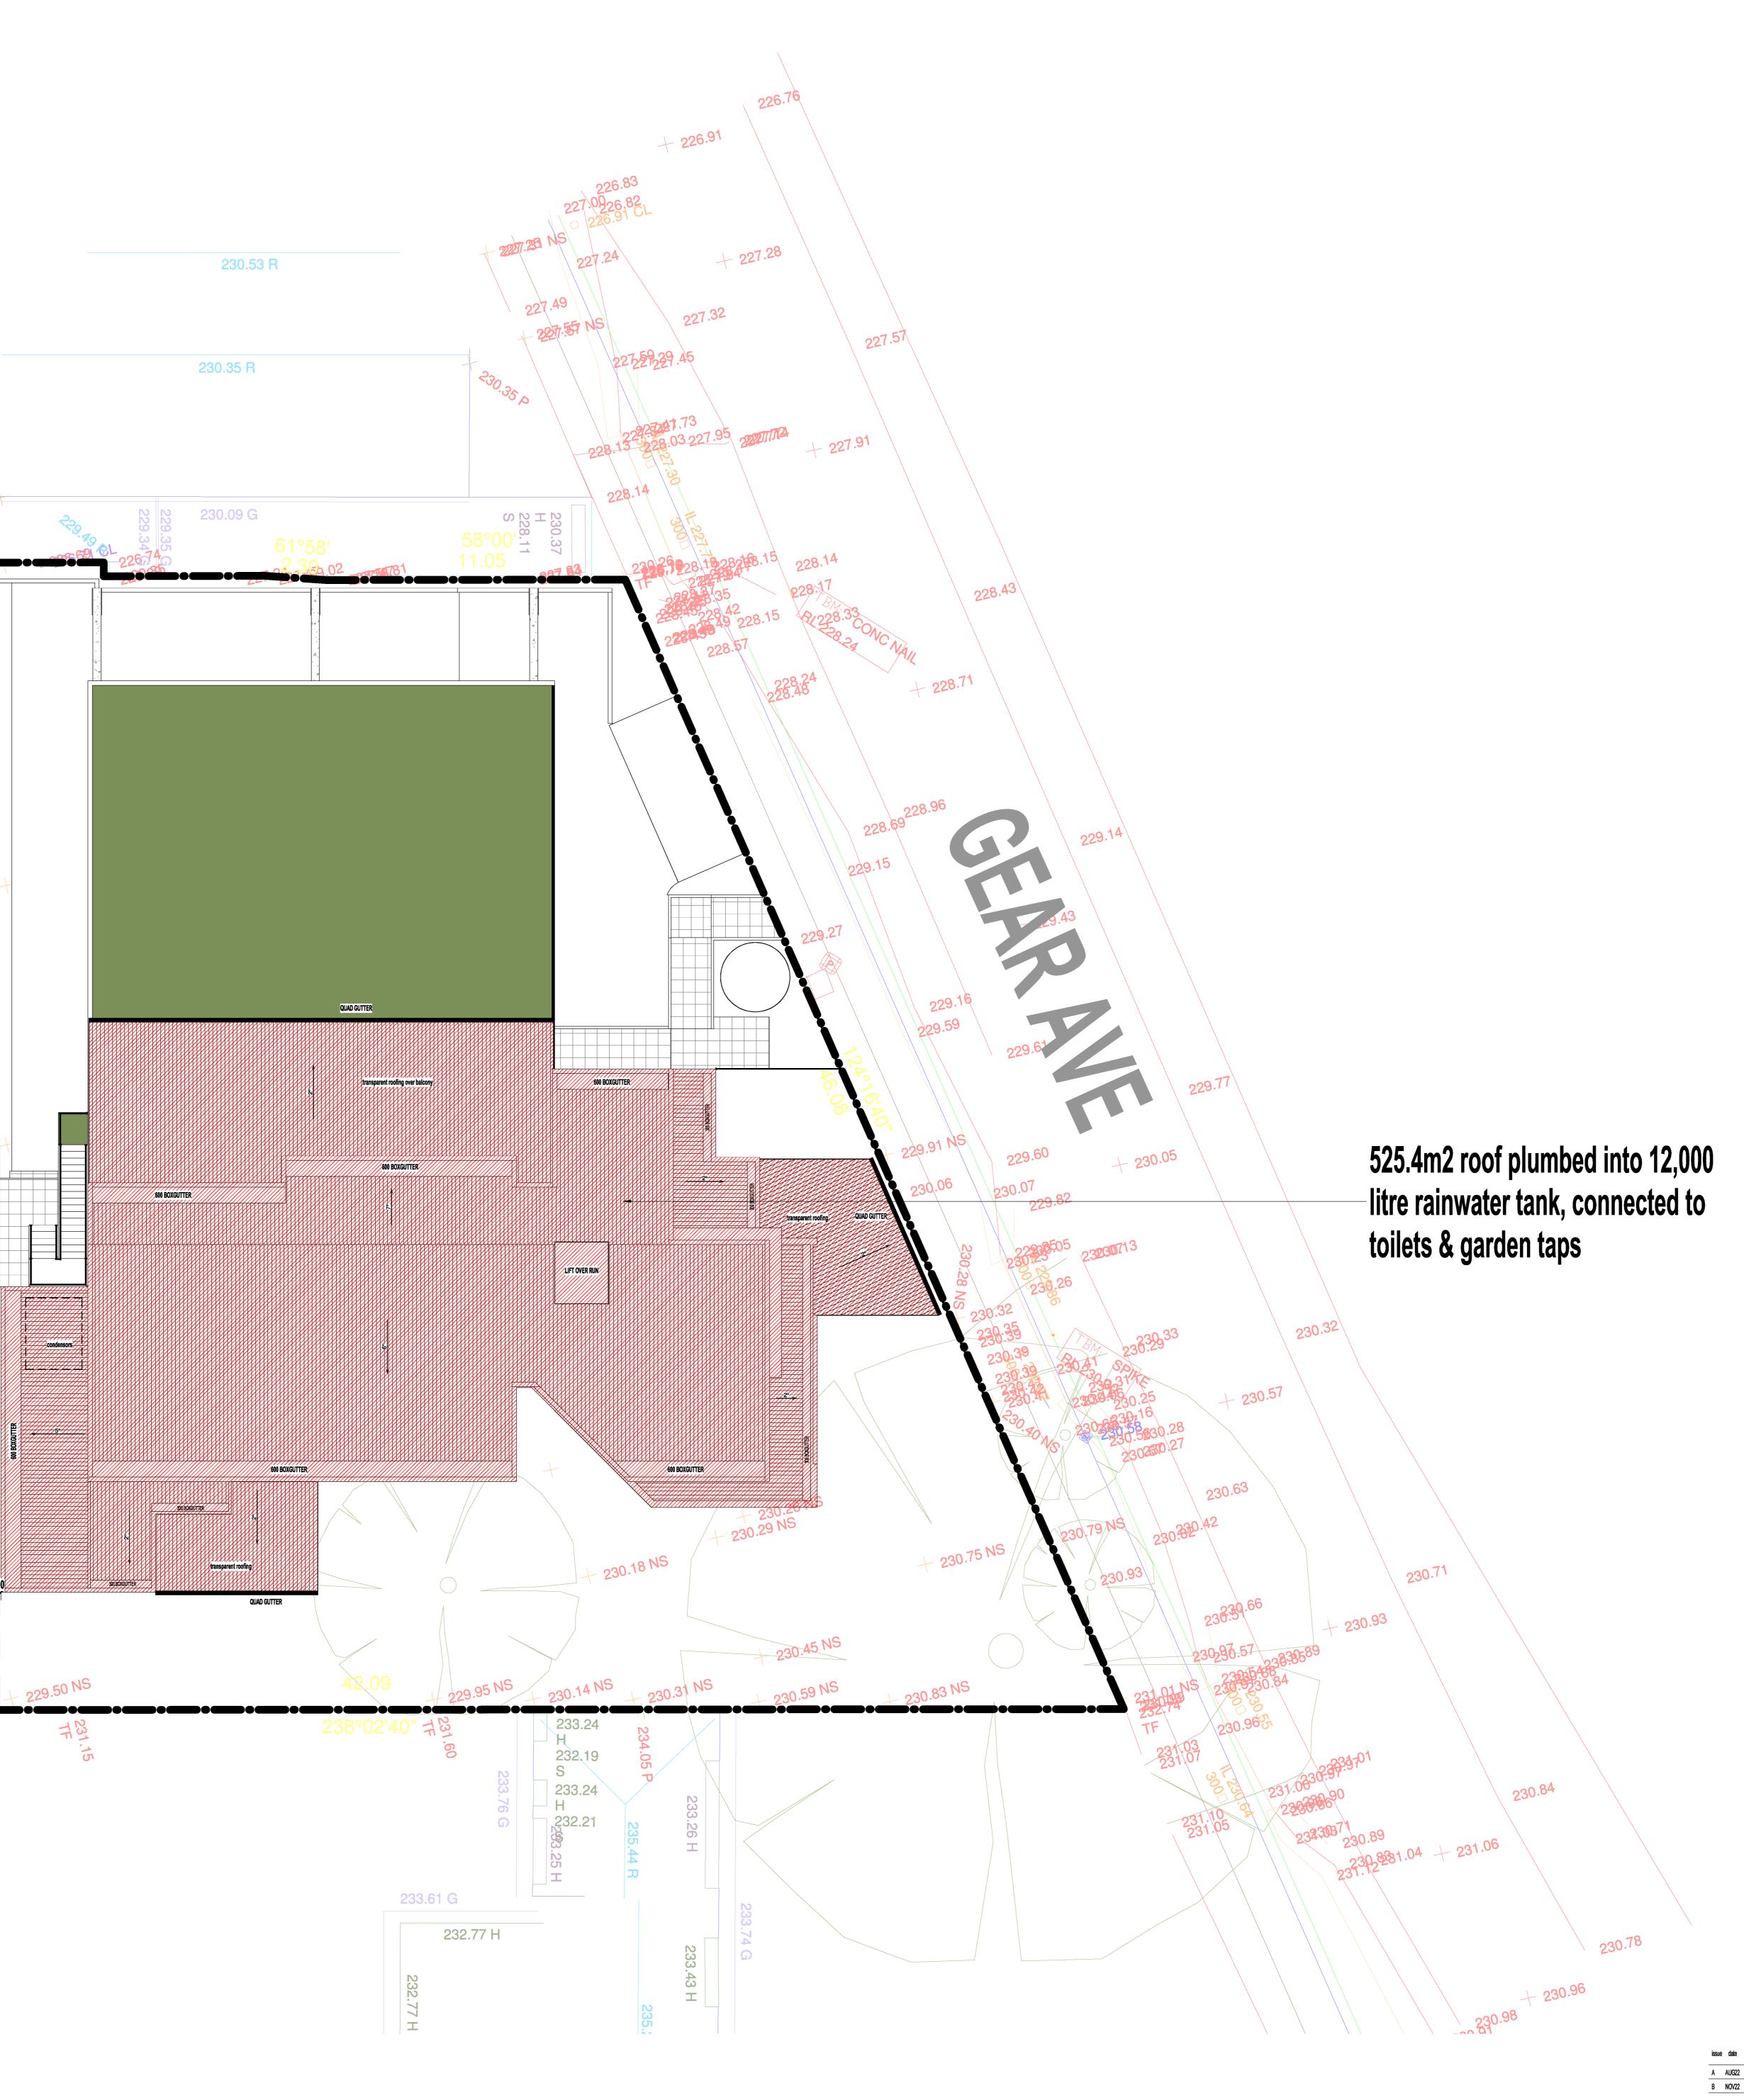

EAST ELEVATION




NORTH ELEVATION

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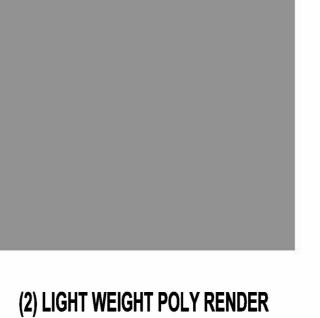



(1) LIGHTWEIGHT CEMENT SHEET TIMBER LOOK VERTICAL GROOVE WITH STAIN FINISH

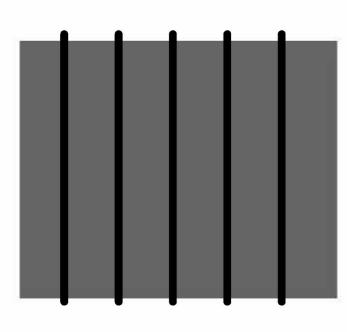

(2) LIGHT WEIGHT POLY RENDER CLADDING. DARK GREY PAINT FINISH





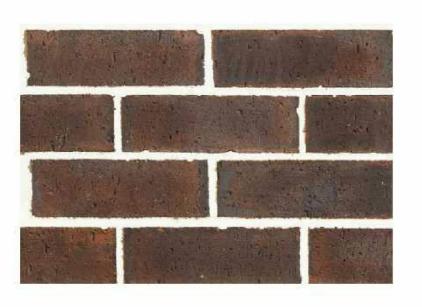

(3) SELECTED BROWN/CHARCOAL BRICK FACE

(4) LIGHT WEIGHT POLY RENDER CLADDING WHITE PAINT FINISH




POWERCOAT BLACK WINDOW/DOOR FRAMES

- PROPOSED RETAINING WALL





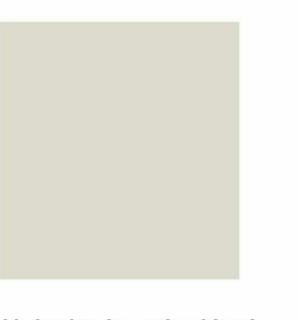



COLORBOND SURFMIST ROOFING VERANDAH

BALCONY BALUSTRADE FRAME




TIMBER PALING ACOUSTIC FENCE


issue date	nole	project		sed development 1A GEAR AVE MT EVELYN			Deg No: TP06
A AUG22	TOWN PLANNING SUBMISSION					v	
B NOV22	RFI				project no.	Х	
		_			date	AUG22	
		- tide	ELEV	ATIONS	scale	1:50	@ A0





(1) LIGHTWEIGHT CEMENT SHEET TIMBER LOOK VERTICAL GROOVE WITH STAIN FINISH CLADDING. GREY PAINT FINISH

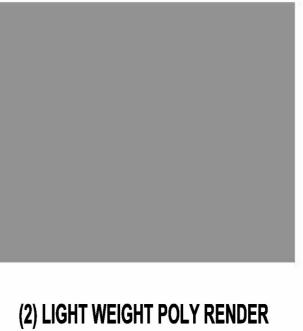

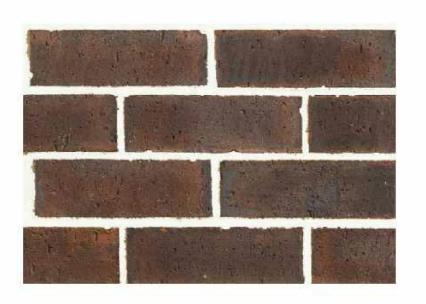

(3) SELECTED BROWN/CHARCOAL **BRICK FACE**

(4) LIGHT WEIGHT POLY RENDER CLADDING WHITE PAINT FINISH



FRAMES

POWERCOAT BLACK WINDOW/DOOR

BALCONY BALUSTRADE FRAME



CHARCOAL DRIVEWAY FINISH






COLORBOND SURFMIST ROOFING VERANDAH


TIMBER PALING ACOUSTIC FENCE


project proposed development @ 1A GEAR AVE MT EVELYN	D#9 No: TP07
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projovno.	Λ
date	AUG22
title ELEVATIONS 2 scale	1:50 @ A0
	1A GEAR AVE MT EVELYN project no. date

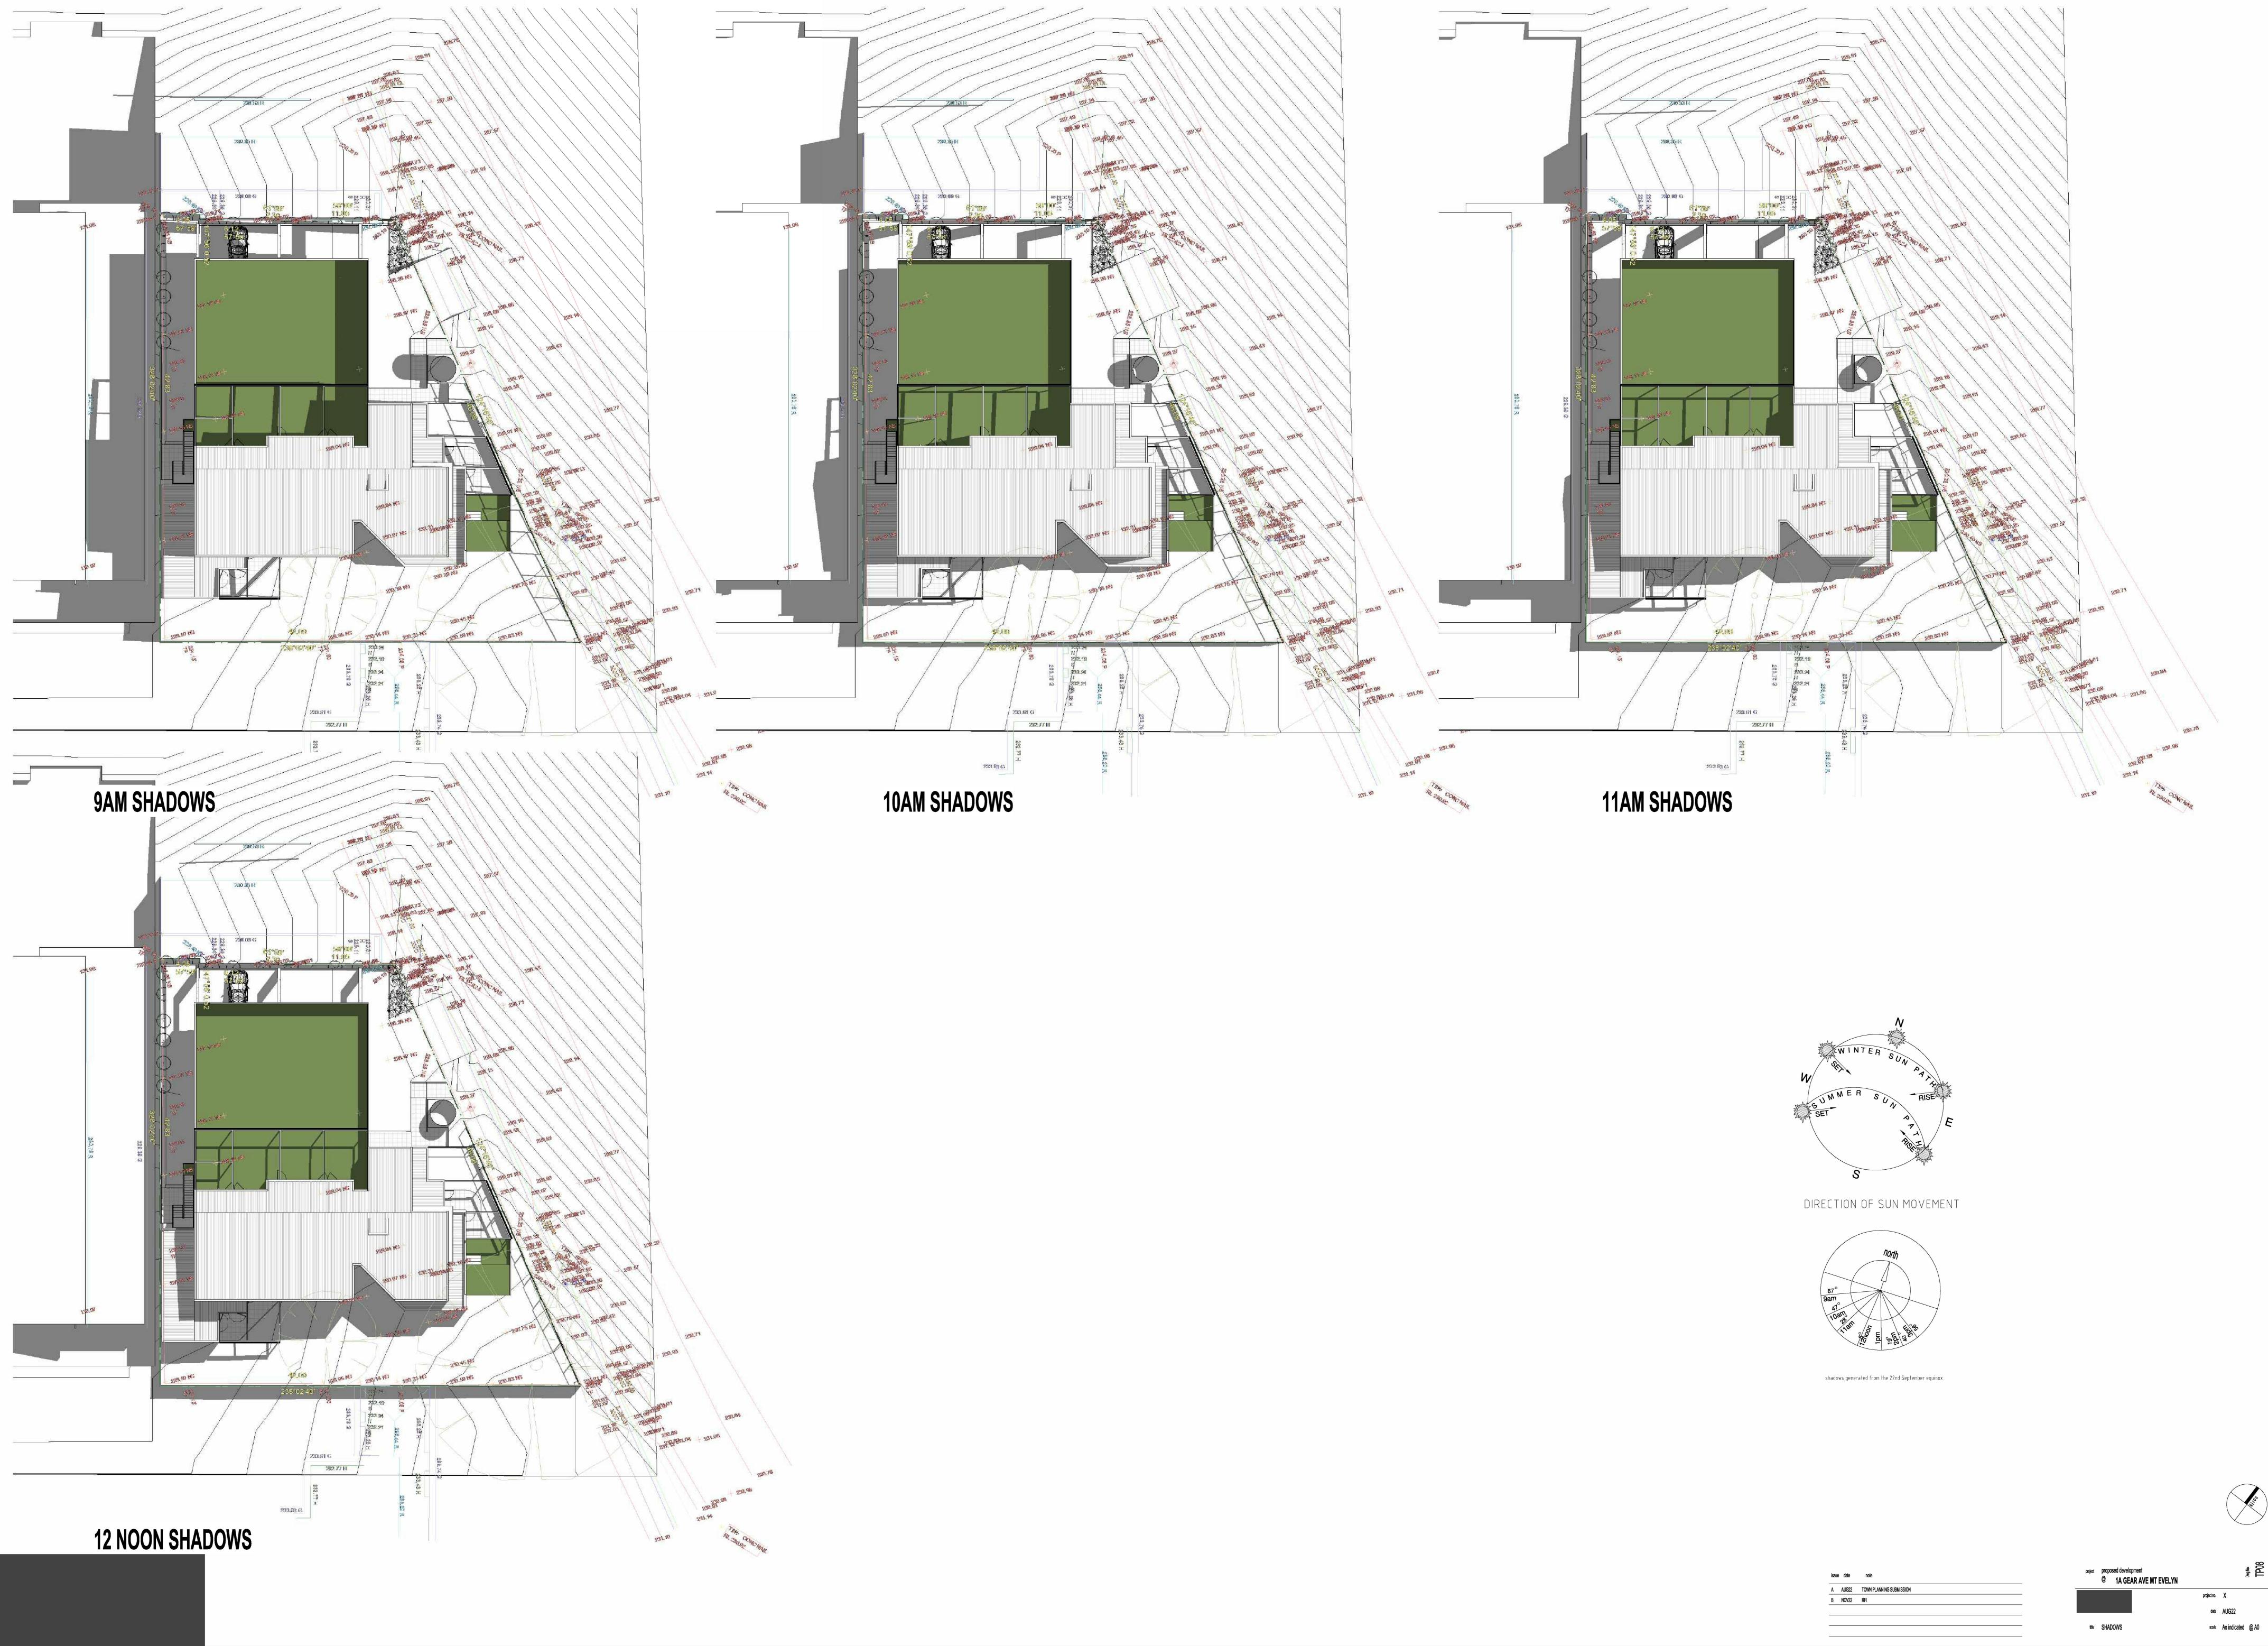

sue	e date	noie	project		sed development 1A GEAR AVE MT EVELYN			Dwg No:	TP08
	AUG22	TOWN PLANNING SUBMISSION					v		
	NOV22	RFI				project no.	Х		
						date	AUG22		
			title	SHAD	OWS	scale	As indicated	0	A0




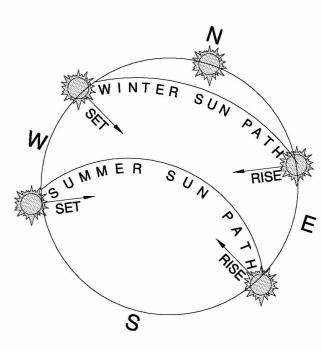

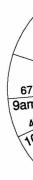

shadows generated from the 22nd September equinox

DIRECTION OF SUN MOVEMENT

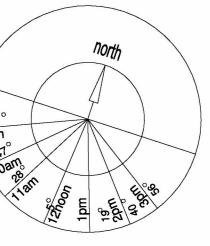



date	nole	p	project	proposed deve @ 1A G	lopment EAR AVE MT EVELYN			1P00
AUG22	TOWN PLANNING SUBMISSION	_					v	
NOV22	RFI					project no.	X	
						date	AUG22	
			title	SHADOWS 2		scale	As indicated	@ A0

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